

A

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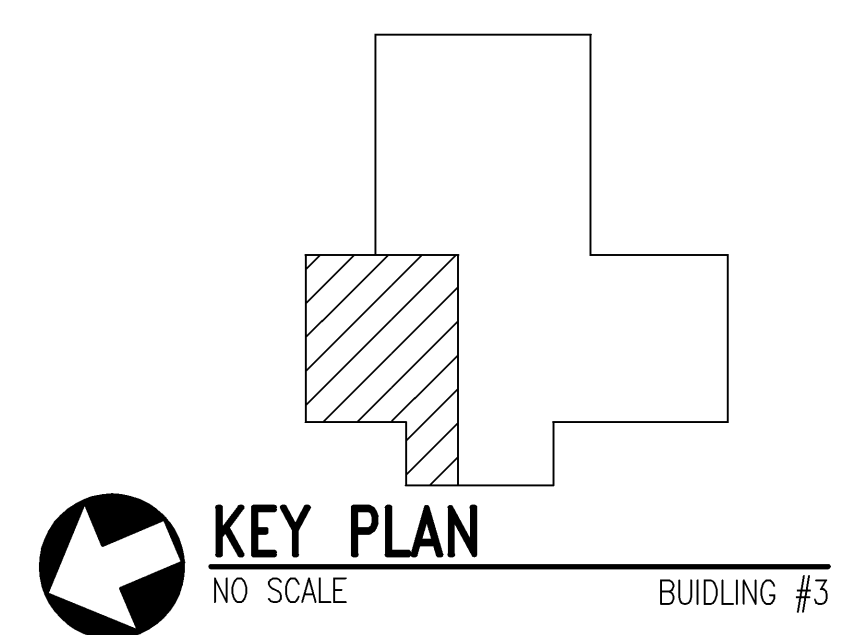
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one eighth inch = one foot
0 4 8 16
one quarter inch = one foot
0 4 8
three eighths inch = one foot
0 4 8
one half inch = one foot
0 4 8
one inch = one foot
0 6 12
three quarters inch = one foot
0 6 12
one and one half inches = one foot
0 6 12
two inches = one foot
0 6 12
three inches = one foot
0 6 12



THIRD FLOOR DEMOLITION ROOM SCHEDULE	
ROOM NUMBER	ROOM NAME
300	CORRIDOR
301	MALE TOILET
302	FEMALE TOILET
303	SOCIAL WORK SVC
303-A	ENTRY
303-A1	ADMIN OFFICE
303-A2	CHIEF SWS OFFICE
303-B	SOCIAL WORK OFFICE
303-C	ENTRY
303-C1	SOCIAL WORK OFFICE
303-C2	SOCIAL WORK OFFICE
303-D	CORRIDOR
303-D1	SOCIAL WORK OFFICE
303-D2	SOCIAL WORK OFFICE
303-E	INTERNS
303-F	SOCIAL WORK OFFICE
303-G	HOUSE KEEPING
304	AUDITORIUM
304-A	KITCHEN
304-B	STORAGE
304-C	STORAGE
304-D	STAGE
305	STAIR

- DEMO WORK NOTES**
- 1 NO SPRINKLER.
 - 2 THIS SPACE IS NOT SPRINKLED. REFER TO NEW WORK PLAN.
 - 3 REMOVE SPRINKLER RISER CONTROL VALVE. PREPARE PIPING FOR INSTALLATION OF NEW VALVE.



SPRINKLER DEMOLITION THIRD FLOOR PLAN
SCALE: 1/4" = 1'-0"

BUILDING 3

CONSULTANTS:  MECHANICAL ELECTRICAL ENGINEERS VIRGINIA BEACH, VA - 757-489-7223	 11220	ARCHITECT:  441 WASHINGTON STREET PORTSMOUTH, VA 23704 (P) 757.393.9900 (F) 757.393.9907	Drawing Title SPRINKLER DEMOLITION THIRD FLOOR PLAN Approved Project Director	Project Title VETERAN'S ADMINISTRATION HOSPITAL - HIGH TECH CONFERENCE ROOM RENOVATION Location FAYETTEVILLE, NORTH CAROLINA Date 05 - 14 - 12 Checked WGO Drawn RAY	Project Number 565-11-101 Building Number 3 Drawing Number FD101 Dwg. 15 of 36	Office of Construction and Facilities Management 
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REMOTE AREA #1	
FILE:	11220-RA1
HAZARD CLASSIFICATION:	LIGHT
SYSTEM TYPE:	WET
DENSITY (GPM/SQ.FT.):	0.10
REQUIRED AREA (SQ.FT.):	1,500
ACTUAL AREA (SQ.FT.):	1,716
SPRINKLERS FLOWING:	15
SPRINKLER DEMAND (GPM):	266 GPM
RESIDUAL PRESSURE AT BOR (PSI):	24 PSI
HOSE ALLOWANCE (GPM):	100
EXCESS AVAILABLE PRESSURE (PSI):	PSI

SPRINKLER NOTE:

THIS BUILDING IS CURRENTLY PROTECTED BY A LIMITED AREA, FULLY AUTOMATIC WET PIPE SPRINKLER SYSTEM. THIS CONTRACTOR SHALL MODIFY AND EXTEND EXISTING SPRINKLER SYSTEM INSTALLATION AS REQUIRED TO SUIT NEW FLOOR PLANS & REFLECTED CEILING PLANS WITHIN THE LIMITS OF CONSTRUCTION. SPRINKLER SYSTEM DESIGN, MATERIALS & INSTALLATION SHALL BE IN ACCORDANCE WITH NFPA 13 STATE, & LOCAL AUTHORITIES. SPACING & LOCATION OF SPRINKLERS SHALL NOT EXCEED THAT PERMITTING FOR LIGHT HAZARD OCCUPANCY.


SPRINKLER HEADS SHOWN ON PLANS INDICATE DESIGN INTENT ONLY. CONTRACTOR IS RESPONSIBLE FOR DETERMINING QUANTITY OF MATERIALS AND FINAL DESIGN OF THE SYSTEM TO MEET NFPA-13 REQUIREMENTS.

THIRD FLOOR ROOM SCHEDULE

ROOM NUMBER	ROOM NAME
300	CORRIDOR
300-A	VESTIBULE
300-B	WOMEN'S TOILET
301	MALE TOILET
302	HOUSE KEEPING
303	NAVIGATION ROOM
304	AUDITORIUM
304-A	KITCHEN
304-B	STORAGE
304-C	STORAGE
304-D	STAGE
305	STAIR

NEW WORK NOTES

- THIS SPACE IS NOT SPRINKLED. EXTEND SPRINKLER FROM OUTSIDE THE SPACE TO PROVIDE ADEQUATE COVERAGE.
- PROPOSE ROUTE FOR NEW SPRINKLER MAIN SERVING RENOVATION SPACE (RM 301,302,303). REMOVE, STORE, AND REINSTALL SPLINE CEILING AS REQUIRED TO PERFORM WORK. PROVIDE UPRIGHT HEADS ON MAIN ABOVE CEILING IN AUDITORIUM.
- PROVIDE NEW OS&Y VALVE W/ TAMPER SWITCH IN SPRINKLER RISER.
- CONNECT NEW SPRINKLER MAIN TO EXISTING SPRINKLER RISER.

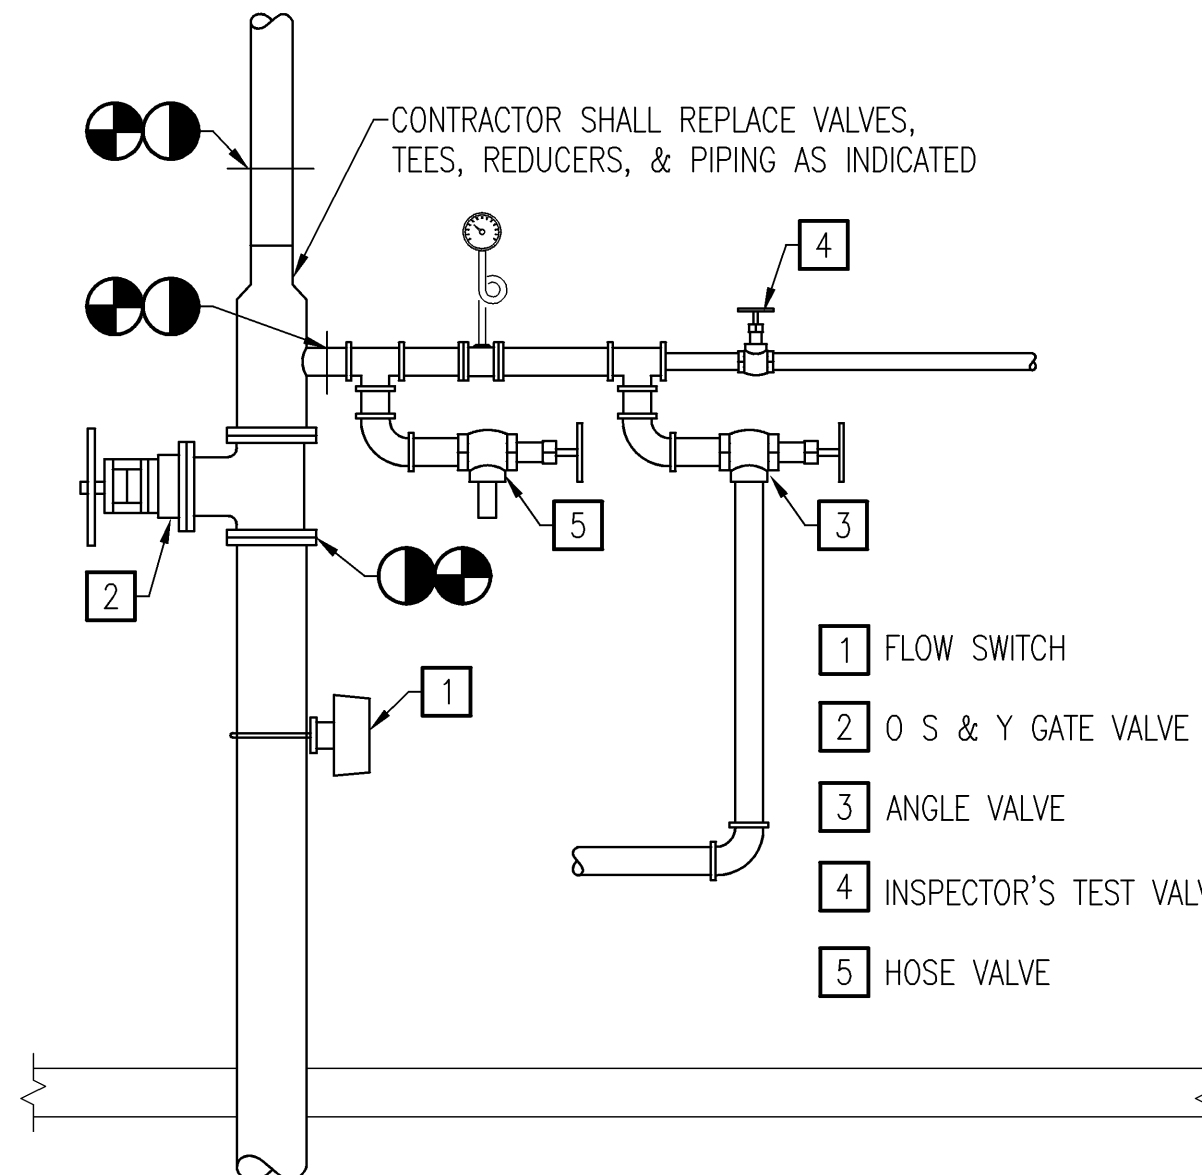

LINE DIAGRAM

NO SCALE:



KEY PLAN

NO SCALE


BUILDING #3

BUILDING 3

SPRINKLER NEW WORK THIRD FLOOR PLAN

SCALE: 1/4" = 1'-0"

CONSULTANTS:

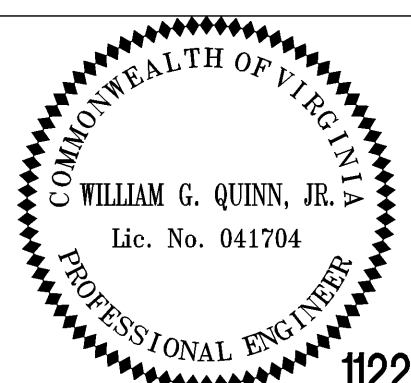

ARCHITECT:



Drawing Title
SPRINKLER NEW WORK THIRD FLOOR PLAN

Approved Project Director

Project Title
VETERAN'S ADMINISTRATION
HOSPITAL - HIGH TECH
CONFERENCE ROOM RENOVATION

Location
FAYETTEVILLE, NORTH CAROLINA

Date
05 - 14 - 12

Checked
WGO

Drawn
RAY

Project Number
565-11-101

Building Number
3

Drawing Number
FA101

Dwg. 16 of 36

Office of
Construction
and Facilities
Management



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SPECIFICATIONS:

- VITREOUS CHINA ADA COMPLIANT FLOOR MOUNTED FLUSH VALVE WATER CLOSET WITH FULLY GLAZED 2" TRAPWAY, ELONGATED SIPHON JET BOWL, 1.1/1.6 GALLONS PER FLUSH.
- PROVIDE EXPOSED, HARDWIRE, SENSOR ACTIVATED HARDWIRE DUAL FLUSH WATER CLOSET FLUSHOMETER. UTILIZE A FULL FLUSH REDUCED FLUSH DUAL FLUSH SYSTEM, EXPOSED, DIAPHRAGM TYPE, CHROME PLATED FLUSHOMETER FOR EITHER LEFT OR RIGHT HAND SUPPLY. PROVIDE TRANSFORMER, BOX (120 VAC/6VAC 25VA). CHROME VALVE BODY, TAILPIECE AND CONTROL STOP SHALL BE IN COMPLIANCE WITH THE APPLICABLE SECTIONS OF ASSE 1037. INSTALLATION CONFORMS TO ADA REQUIREMENTS AND 1" I.P.S. SCREWDRIVER BAK-CHEK ANGLE STOP DESIGN BASED ON SLOAN ECOS-111 OR EQUAL.

DESIGN BASED ON AMERICAN STANDARD "MADERA" OR EQUAL

MARK	DESCRIPTION	TRAP	PIPE SIZES				MOUNTING
			HW	CW	WP	VP	
P-1	ADA - FLUSH VALVE WATER CLOSET	INTEGRAL	-	1"	4"	2"	FLOOR

ADA - WATER CLOSET

SPECIFICATIONS:

- VITREOUS CHINA ADA COMPLIANT WALL MOUNTED WHEELCHAIR ACCESSIBLE LAVATORY WITH FRONT OVERFLOW & SINGLE HOLE ON SELF DRAINING DECK.
- PROVIDE SENSOR ACTIVATED ELECTRONIC HAND WASHING FAUCET WITH METAL THROAT PLATE, FOR TEMPERED OR HOT/COLD WATER OPERATION. PROVIDE 0.5 GPM/1.9 LPM VANDAL RESISTANT SPRAY HEAD. UTILIZE 120 VAC/24 VAC TRANSFORMER. PROVIDE BOX MOUNT. PROVIDE 120 VAC/24 VAC, 50/60 HZ (40 VA) - BOX MOUNT AND TRANSFORMER. PROVIDE CHROME PLATED BRASS GRID STRAINER WITH 1 1/4" OUTLET TUBE. DESIGN BASED ON SLOAN OPTIMA ETF-880 SERIES OR EQUAL.
- CHROME FINISH CAST BRASS LOOSE KEY ANGLE STOPS WITH CHROME FINISH RIGID SUPPLY RISERS. OFFSET GRID STRAINER AND ADJUSTABLE 'P'-TRAP. PROVIDE LAVSHIELD BY TRUEBRO PROTECTIVE LAVATORY ENCLOSURE OR EQUAL.
- CONCEALED FLOOR MOUNT SUPPORT. WALL BRACKETS SHALL NOT BE USED.
- PROVIDE TEMPERATURE LIMITATION DEVICE TO MEET THE ASSE 1070 STANDARD.

DETAIL BASED ON WHEEL CHAIR USER LAVATORY OR EQUAL

MARK	DESCRIPTION	TRAP	PIPE SIZES				MOUNTING
			HW	CW	WP	VP	
P-2	ADA - WHEELCHAIR LAVATORY	'P'-TRAP	1/2"	1/2"	2"	1-1/2"	WALL MOUNTED

ADA - WHEELCHAIR LAVATORY

SPECIFICATIONS:

- VITREOUS CHINA ADA COMPLIANT WALL MOUNTED FLUSH VALVE URINAL WITH FULLY GLAZED 2" TRAPWAY, 0.125 GALLON PER FLUSH.
- PROVIDE EXPOSED, HARDWIRE, SENSOR ACTIVATED HARDWIRE URINAL FLUSHOMETER. PROVIDE 0.13 HIGH EFFICIENCY (0.13 GPF/0.5 LPF) (PINT FLUSH). CHROME BODY, TAILPIECE AND CONTROL STOP SHALL BE IN CONFORMANCE WITH ASTM ALLOY CLASSIFICATION FOR SEMI-RED BRASS. VALVE SHALL BE IN COMPLIANCE WITH THE APPLICABLE SECTIONS OF ASSE 1037. INSTALLATION CONFORMS TO ADA REQUIREMENTS AND 3/4" I.P.S. SCREWDRIVER BAK-CHEK ANGLE STOP. PROVIDE TRANSFORMER, BOX (120 VAC/6 VAC 25 VA). DESIGN BASED ON SLOAN ECOS 186-0.13 OR EQUAL.
- CONCEALED FLOOR MOUNT SUPPORT. WALL BRACKETS SHALL NOT BE USED.

DESIGN BASED ON AMERICAN STANDARD "WASHBROOK" OR EQUAL

MARK	DESCRIPTION	TRAP	PIPE SIZES				MOUNTING
			HW	CW	WP	VP	
P-3	ADA - FLUSH VALVE URINAL	INTEGRAL	-	3/4"	2"	1-1/2"	WALL

ADA - URINAL

SPECIFICATIONS:

- MOP BASIN SHALL BE 24"Wx24"Lx10"H SINGLE PIECE MOLDED STONE.
- FAUCET SHALL BE EXPOSED YOKE WALL MOUNT UTILITY FAUCET WITH CAST BRASS BODY, 1/4 TURN CERAMIC VALVE CARTRIDGES, INTEGRAL VACUUM BREAKER & WALL BRACE. PROVIDE WITH OFFSET SHANKS WITH INTEGRAL STOPS.
- MOUNT FAUCET 36" AFF.
- PROVIDE WALL MOUNTED MOP BRACKET, STAINLESS STEEL STRAINER, QUICK DRAIN CONNECTIONS, 30" HOSE & HOSE BRACKET.

DETAIL BASED ON FIAT, "MOLDED STONE" SERIES OR EQUAL

MARK	DESCRIPTION	TRAP	PIPE SIZES				MOUNTING
			HW	CW	WP	VP	
P-4	FLOOR MOUNTED MOP BASIN	'P'-TRAP	3/4"	3/4"	3"	1-1/2"	FLOOR

MOP BASIN

SPECIFICATIONS:

- SEAMLESS DIE DRAWN 18 GAUGE STAINLESS STEEL SINK WITH EXPOSED SURFACE POLISHED TO A NON-POROUS FINISH, FULLY COATED UNDERSIDE INSULATED FOR SOUND AND CONDENSATE, DESIGNED BASED ON ELKAY DLR372210 W/FOUR HOLES
- 8" CENTER, TWO HANDLE BELOW DECKMOUNT FAUCET, POLISHED CHROME PLATED FINISH TRIM, CAST BRASS BODIES, BRASS SPOUT AND TRIM, GOOSENECK SWING SPOUT, STANDARD 2.2 GPM FLOW CONTROL AERATOR, 4" BLADE HANDLES, METAL HANDLES WITH HOSE SPRAY AS MANUFACTURED BY ZURN, DESIGNED BASED ON Z831C4-HS-ICT-4F.
- CHROME FINISH CAST BRASS LOOSE KEY ANGLE STOPS WITH CHROME FINISH RIGID SUPPLY RISERS. OFFSET GRID STRAINER AND ADJUSTABLE 'P'-TRAP.

MARK	DESCRIPTION	TRAP	PIPE SIZES				MOUNTING
			HW	CW	WP	VP	
P-5	KITCHEN SINK (2 COMPARTMENT) [19"Wx33"Lx7-1/2"D]	'P'-TRAP	1/2"	1/2"	2"	1-1/2"	UNDER MOUNT

KITCHEN SINK UNDERMOUNT

SPECIFICATIONS:

- SPACE SAVER RECESSED VALVE BOX WITH 1/2" ANGLE STOP WITH 1/4" COMPRESSION CONNECTION.
- G90 HOT DIPPED GALVANIZED STEEL BOX. PAINT AS DIRECTED BY ARCHITECT.
- BOTTOM OF BOX 6"-12" AFF.

DETAIL BASED ON GUY GRAY

MARK	DESCRIPTION	TRAP	PIPE SIZES				MOUNTING
			HW	CW	WP	VP	
P-6	METAL ICE MAKER WALL BOX	-	-	1/2"	-	-	WALL

METAL ICE MAKER WALL BOX

SPECIFICATIONS:

- VITREOUS CHINA ADA COMPLIANT WALL MOUNTED FLUSH VALVE WATER CLOSET WITH FULLY GLAZED 2" TRAPWAY, ELONGATED SIPHON JET BOWL, 1.1/1.6 GALLONS PER FLUSH. CONCEALED FLOOR MOUNT SUPPORT. WALL BRACKETS SHALL NOT BE USED.
- PROVIDE EXPOSED, HARDWIRE, SENSOR ACTIVATED HARDWIRE DUAL FLUSH WATER CLOSET FLUSHOMETER. UTILIZE A FULL FLUSH, REDUCED FLUSH DUAL FLUSH SYSTEM, EXPOSED, DIAPHRAGM TYPE, CHROME PLATED FLUSHOMETER FOR EITHER LEFT OR RIGHT HAND SUPPLY. PROVIDE TRANSFORMER, BOX (120 VAC/6VAC 25VA). CHROME VALVE BODY, TAILPIECE AND CONTROL STOP SHALL BE IN COMPLIANCE WITH THE APPLICABLE SECTIONS OF ASSE 1037. INSTALLATION CONFORMS TO ADA REQUIREMENTS AND 1" I.P.S. SCREWDRIVER BAK-CHEK ANGLE STOP DESIGN BASED ON SLOAN ECOS-111 OR EQUAL.

DESIGN BASED ON AMERICAN STANDARD "AFWALL" OR EQUAL

MARK	DESCRIPTION	TRAP	PIPE SIZES				MOUNTING
			HW	CW	WP	VP	
P-7	ADA - FLUSH VALVE WATER CLOSET	INTEGRAL	-	1"	4"	2"	WALL MOUNTED

ADA - WATER CLOSET

<div>Revisions</div> <table><thead><tr><th></th><th>Date</th></tr></thead><tbody><tr><td> </td><td> </td></tr><tr><td> </td><td> </td></tr><tr><td> </td><td> </td></tr><tr><td> </td><td> </td></tr><tr><td> </td><td> </td></tr><tr><td> </td><td> </td></tr><tr><td> </td><td> </td></tr><tr><td> </td><td> </td></tr><tr><td> </td><td> </td></tr></tbody></table>		Date																			<div>CONSULTANTS:</div> <div>Pace COLLABORATIVE MECHANICAL ELECTRICAL ENGINEERS VIRGINIA BEACH, VA - 757-489-7223</div>	<div></div>	<div>ARCHITECT:</div> <div>INNOVATE Architecture + Interiors 441 WASHINGTON STREET PORTSMOUTH, VA 23704 (P) 757.393.9900 (F) 757.393.9907</div>	<div>Drawing Title PLUMBING FIXTURE PLATES</div> <div>Approved Project Director</div>	<div>Project Title VETERAN'S ADMINISTRATION HOSPITAL - HIGH TECH CONFERENCE ROOM RENOVATION</div> <div>Location FAYETTEVILLE, NORTH CAROLINA</div> <div>Date 05 - 14 - 12</div>	<div>Project Number 565-11-101</div> <div>Building Number 3</div> <div>Drawing Number PL002 Dwg. 18 of 36</div> <div>Checked WGO</div> <div>Drawn MAJ</div>	<div>Office of Construction and Facilities Management</div> <div>Department of Veterans Affairs</div>
		Date																									

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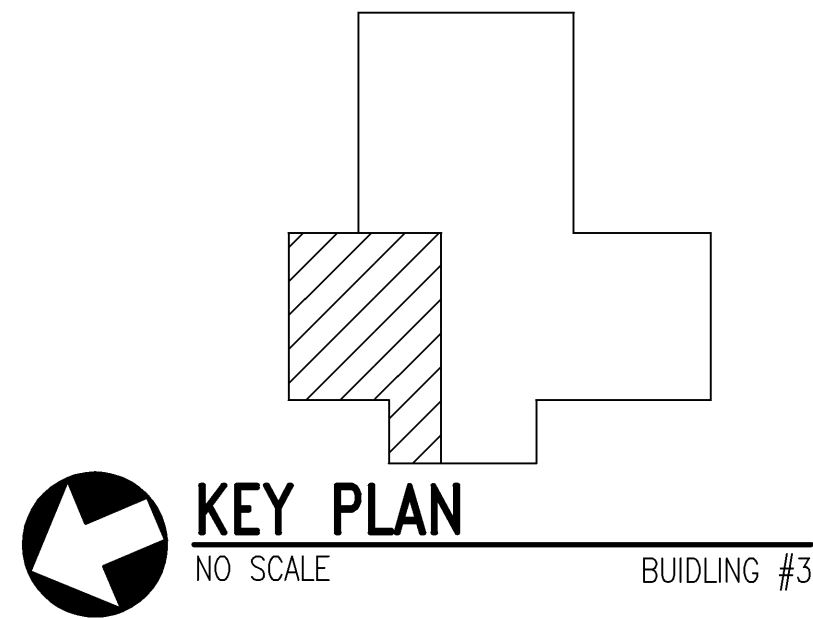


THIRD FLOOR DEMOLITION ROOM SCHEDULE

ROOM NUMBER	ROOM NAME
300	CORRIDOR
301	MALE TOILET
302	FEMALE TOILET
303	SOCIAL WORK SVC
303-A	ENTRY
303-A1	ADMIN OFFICE
303-A2	CHIEF SWS OFFICE
303-B	SOCIAL WORK OFFICE
303-C	ENTRY
303-C1	SOCIAL WORK OFFICE
303-C2	SOCIAL WORK OFFICE
303-D	CORRIDOR
303-D1	SOCIAL WORK OFFICE
303-D2	SOCIAL WORK OFFICE
303-E	INTERNS
303-F	SOCIAL WORK OFFICE
303-G	HOUSE KEEPING
304	AUDITORIUM
304-A	KITCHEN
304-B	STORAGE
304-C	STORAGE
304-D	STAGE
305	STAIR

DEMO WORK NOTES

- 1 REMOVE AND DISPOSE OF FIXTURE COMPLETE.
- 2 REMOVE AND DISPOSE OF FIXTURE COMPLETE, CAP PIPING IN WALL. REFER TO NEW WORK PLANS.
- 3 REMOVE AND DISPOSE OF FIXTURE COMPLETE, ROUGH IN TO BE MODIFIED TO SUIT NEW FIXTURE LAYOUT, REFER TO NEW WORK PLAN.
- 4 CAP WASTE PIPE BELOW FLOOR.
- 5 CAP VENT PIPE ABOVE CEILING.
- 6 REMOVE WATER PIPE AND CAP AT MAIN.
- 7 REMOVE EXISTING FD AND P-TRAP COMPLETE. REFER TO NEW WORK PLAN.
- 8 AT LOCATION OF EXISTING HOT AND COLD WATER CONTRACTOR SHALL CAREFULLY REMOVE HARD CEILING ABOVE EXISTING ACOUSTICAL TILE CEILING TO GAIN ACCESS TO EXISTING PIPE.
- 9 REMOVE TOILET AND CARRIER SUPPORT. REFER TO NEW WORK PLAN. CAP PIPE IN WALL.
- 10 PROVIDE OPENING IN CONCRETE FOR NEW 2" FD W/TP. REFER TO NEW WORK PLAN. REFER TO STRUCTURAL FLOOR PLAN PL001.
- 11 REMOVE DRINKING FOUNTAIN AND CAP WASTE AND WATER. ABOVE CEILING AND OR BELOW FLOOR.
- 12 REMOVE ALL WASTE AND ASSOCIATED PIPING NOT REQUIRED FOR NEW FIXTURE ROUGH-INS.
- 13 EXISTING CW SUPPLY AND OR HW SUPPLY FOR EXISTING FIXTURE SHALL BE UTILIZED TO PROVIDE WATER SUPPLY FOR OTHER FIXTURES. REFER TO NEW WORK.
- 14 COORDINATE SHUT DOWN OF MAIN WATER IF FREEZING PIPE CAN NOT BE PERFORMED AND OR ISOLATION VALVE IS NOT AVAILABLE.
- 15 COORDINATE SHUT DOWN OF ANY ADJACENT FIXTURES IF THE DWV SYSTEM NEEDS TO BE REMOVED.
- 16 EXISTING VENT TO BE EXTENDED, REFER TO NEW WORK.
- 17 REMOVE WALL MOUNTED FIXTURE CARRIER.
- 18 REMOVE MEDICAL GAS ALARM COMPLETE.




PLUMBING DEMOLITION THIRD FLOOR PLAN

SCALE: 1/4" = 1'-0"

BUILDING #3

Revisions:	CONSULTANTS: Pace COLLABORATIVE MECHANICAL ELECTRICAL ENGINEERS VIRGINIA BEACH, VA - 757-489-7223	 11220	ARCHITECT: INNOVATE Architecture • Interiors 441 WASHINGTON STREET PORTSMOUTH, VA 23704 (P) 757.393.9900 (F) 757.393.9907	Drawing Title PLUMBING DEMOLITION THIRD FLOOR PLAN Approved Project Director	Project Title VETERAN'S ADMINISTRATION HOSPITAL - HIGH TECH CONFERENCE ROOM RENOVATION Location FAYETTEVILLE, NORTH CAROLINA Date 05 - 14 - 12 Checked WGO Drawn MAJ	Project Number 565-11-101 Building Number 3 Drawing Number PD101 Dwg. 19 of 36	Office of Construction and Facilities Management Department of Veterans Affairs
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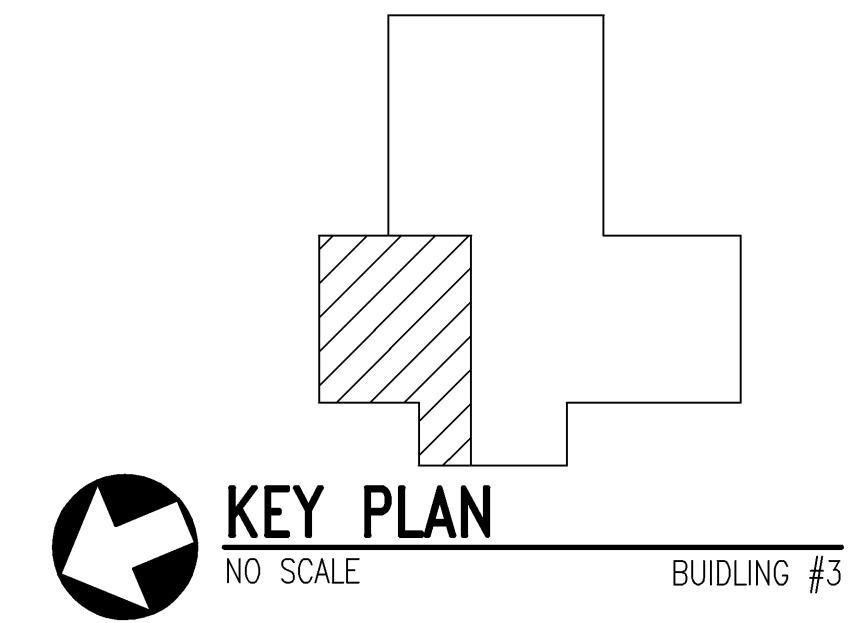
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PLUMBING NEW WORK THIRD FLOOR PLAN
SCALE: 1/4" = 1'-0"


BUILDING #3

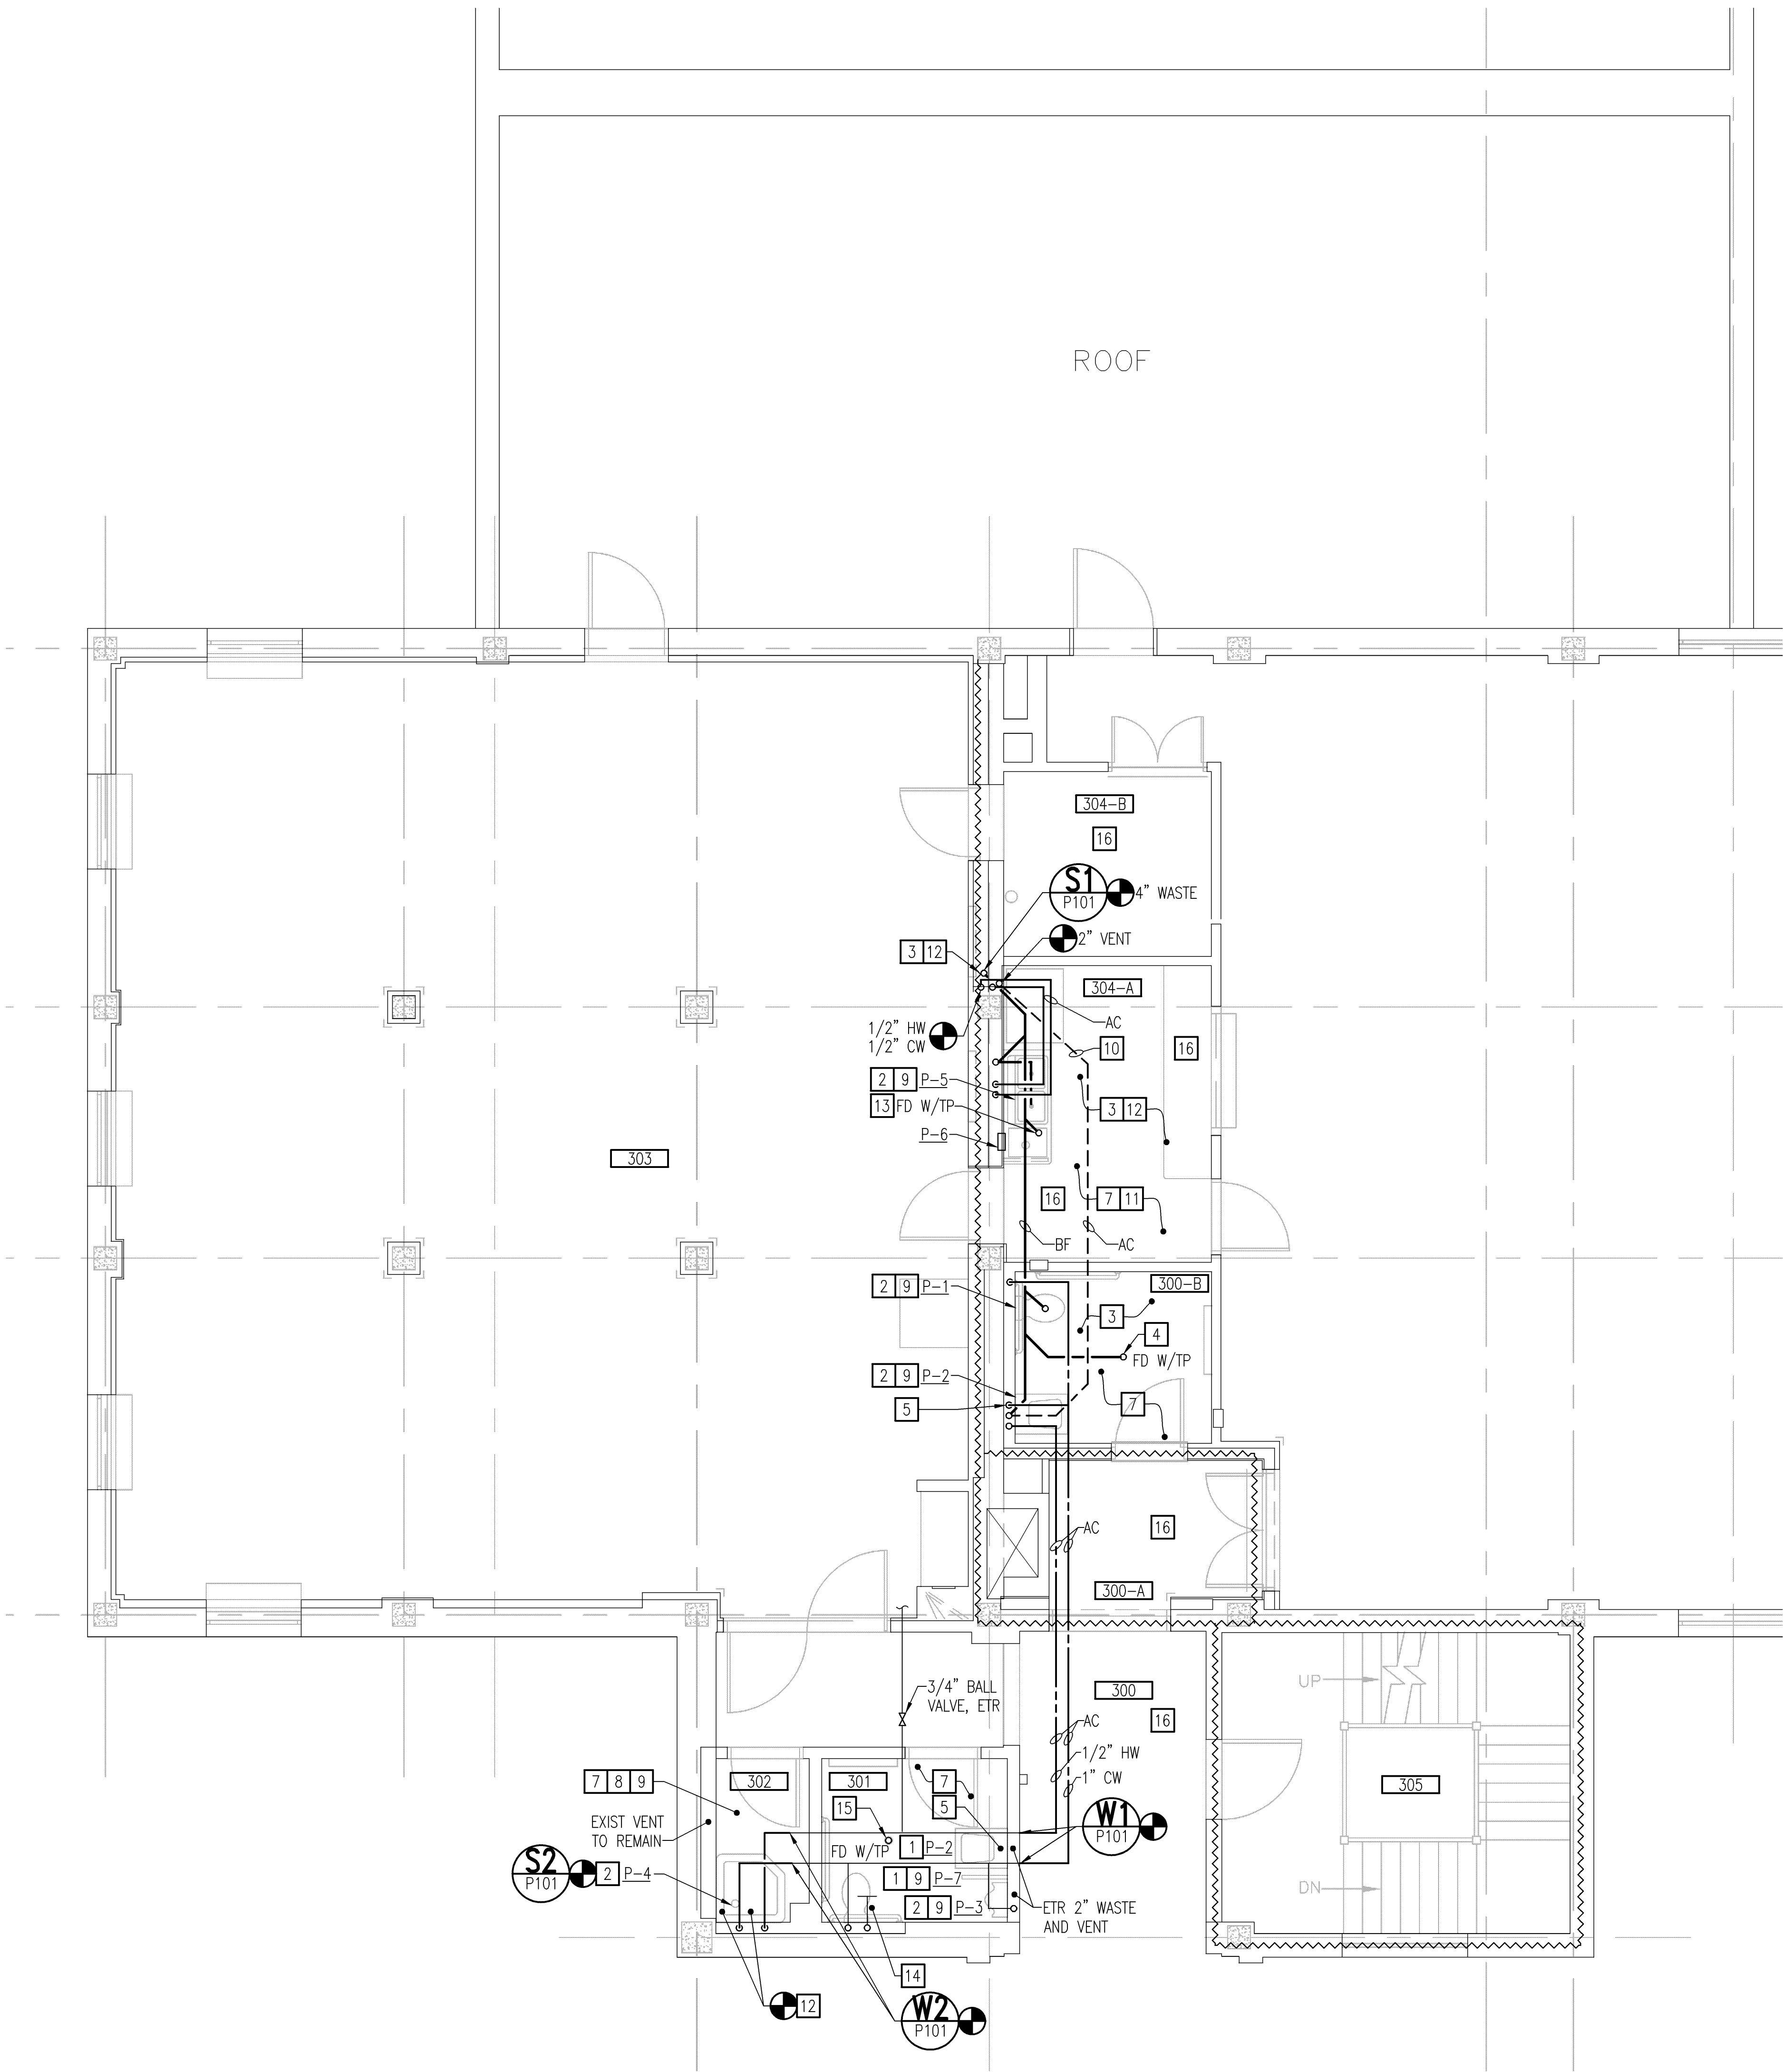THIRD FLOOR ROOM SCHEDULE	
ROOM NUMBER	ROOM NAME
300	CORRIDOR
300-A	VESTIBULE
300-B	WOMENS TOILET
301	MALE TOILET
302	HOUSE KEEPING
303	NAVIGATION ROOM
304	AUDITORIUM
304-A	KITCHEN
304-B	STORAGE
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305	STAIR




- NEW WORK NOTES**
- 1] PROVIDE NEW FIXTURE COMPLETE; ADJUST ROUGH IN TO MEET ADA REQUIREMENTS. PROVIDE NEW CARRIER FOR WALL HUNG FIXTURES ONLY.
 - 2] PROVIDE NEW FIXTURE COMPLETE; PROVIDE PIPING AS REQUIRED TO ROUGH IN FIXTURE AT NEW LOCATION. CONNECT WASTE AT ORIGINAL POINT OF CONNECTION. CONNECT VENT TO EXISTING VENT FOR ORIGINAL LOCATION. RELOCATE WATER TO NEW FIXTURE LOCATION.
 - 3] PROVIDE NEW WASTE SYSTEM BELOW FLOOR AND VENT SYSTEM ABOVE CEILING. COORDINATE ALL WORK SO AS NOT TO DISTURB THE NORMAL OPERATION OF THIS FACILITY.
 - 4] PROVIDE NEW FLOOR DRAIN WITH TRAP PRIMER AND P-TRAP. LOCATE TRAP PRIMER DEVICE UNDER LAVATORY AND PIPE DOWN TO FLOOR DRAIN.
 - 5] LOCATE AUTOMATIC TRAP PRIMER VALVE UNDER SINK.
 - 6] CONNECT NEW WASTE TO EXISTING PIPE.
 - 7] COORDINATE WITH VA MAINTENANCE STAFF FOR REMOVAL OR RELOCATION OF SANITARY WASTE OR DOMESTIC HOT WATER OR COLD WATER..
 - 8] PROVIDE FLOOR MOUNT MOP SINK AND FAUCET. CONNECT TO EXISTING WATER AND WASTE.
 - 9] UTILIZE EXISTING CW AND HW SUPPLY PIPE FOR PROVIDING DISTRIBUTION TO NEW FIXTURES ROUTE PIPE IN CHASE OR ABOVE CEILING, AS WILL APPLY.
 - 10] EXTEND VENT INTO CEILING TO EXISTING VENT.
 - 11] PROVIDE 2" VENT PIPING AND CONNECT TO EXISTING VENT SYSTEM.
 - 12] CONNECT NEW SANITARY WASTE PIPE TO EXISTING CAST IRON WASTE IN CEILING BELOW.
 - 13] PROVIDE 1/2" CW SUPPLY AND WATER FILTER IN SINK CABINET. PROVIDE FILLER RECOMMENDED BY THE MANUFACTURER. PROVIDED 3" FD ICE MAKER FOR ICE MACHINE. PROVIDE BACKFLOW PREVENTION DEVICE FOR ICE MACHINE.
 - 14] PROVIDE CARRIER SUPPORTS AND SET UP FOR AN ADA INSTALLATION WITH EXISTING WASTE.
 - 15] PROVIDE NEW FLOOR DRAIN WITH TRAP PRIMER AND P-TRAP. LOCATE TRAP PRIMER DEVICE UNDER LAVATORY AND PIPE DOWN TO EXISTING DRAIN, REPLACE TRAP.
 - 16] REFER TO ARCHITECTURAL PLANS FOR CEILING HEIGHT. RUN ALL PIPE TO COORDINATE WITH NEW OR EXISTING FIXTURES, DUCT WORK OR PIPING. CONTRACTOR SHALL ROUTE PIPING ABOVE LAY-IN CEILING BUT BELOW HARD CEILING.


CEILING NOTE:
CONTRACTOR SHALL REMOVE, STORE, & INSTALL CEILINGS IN SPACES BELOW AS REQUIRED TO PERFORM WORK.

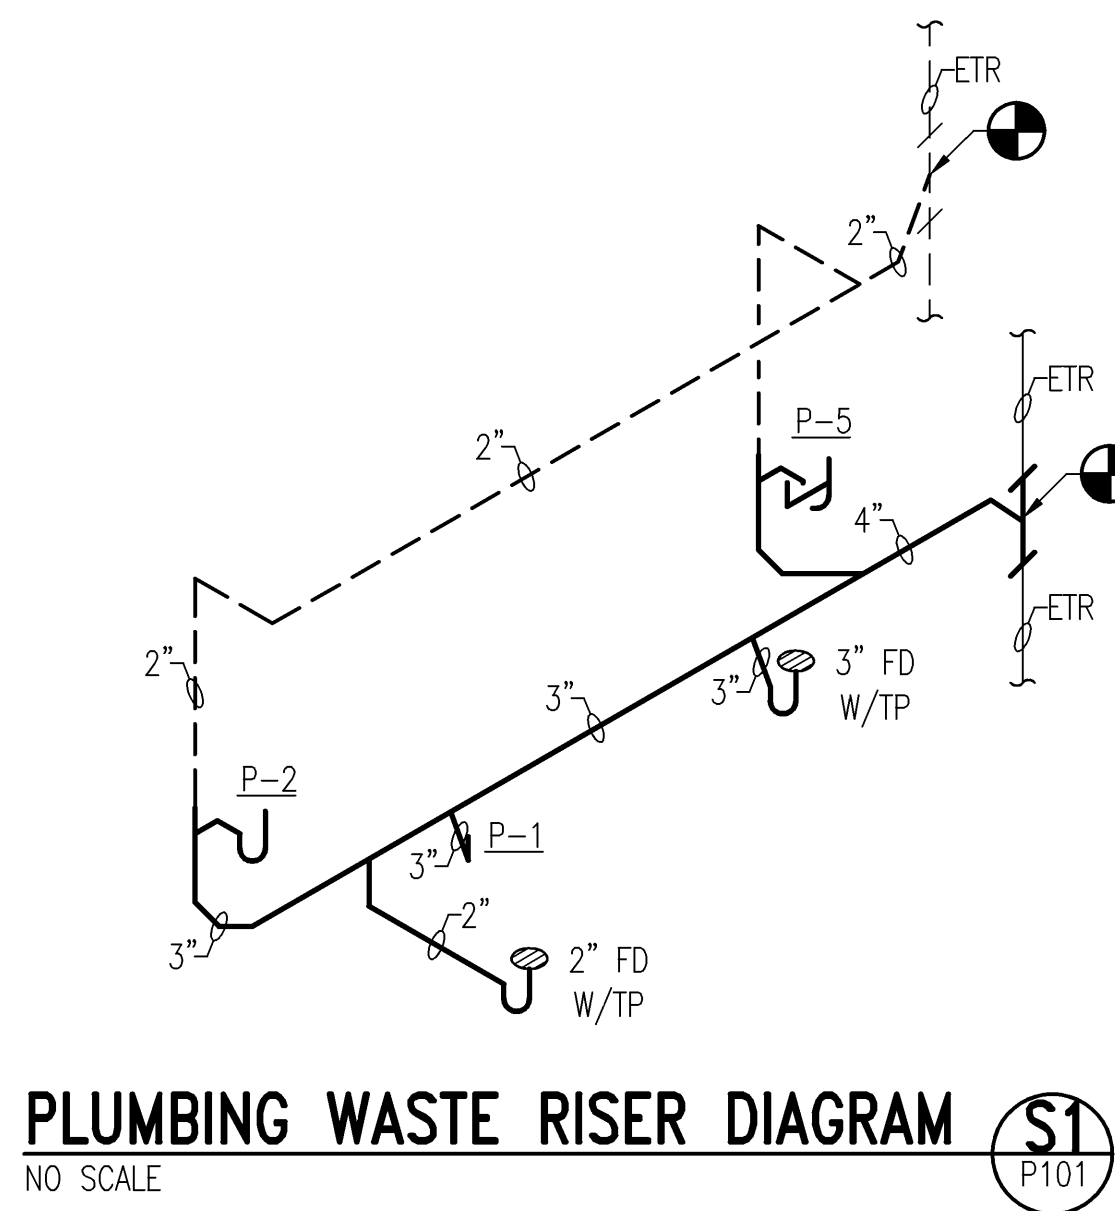


PLUMBING WASTE RISER DIAGRAM S1
NO SCALE

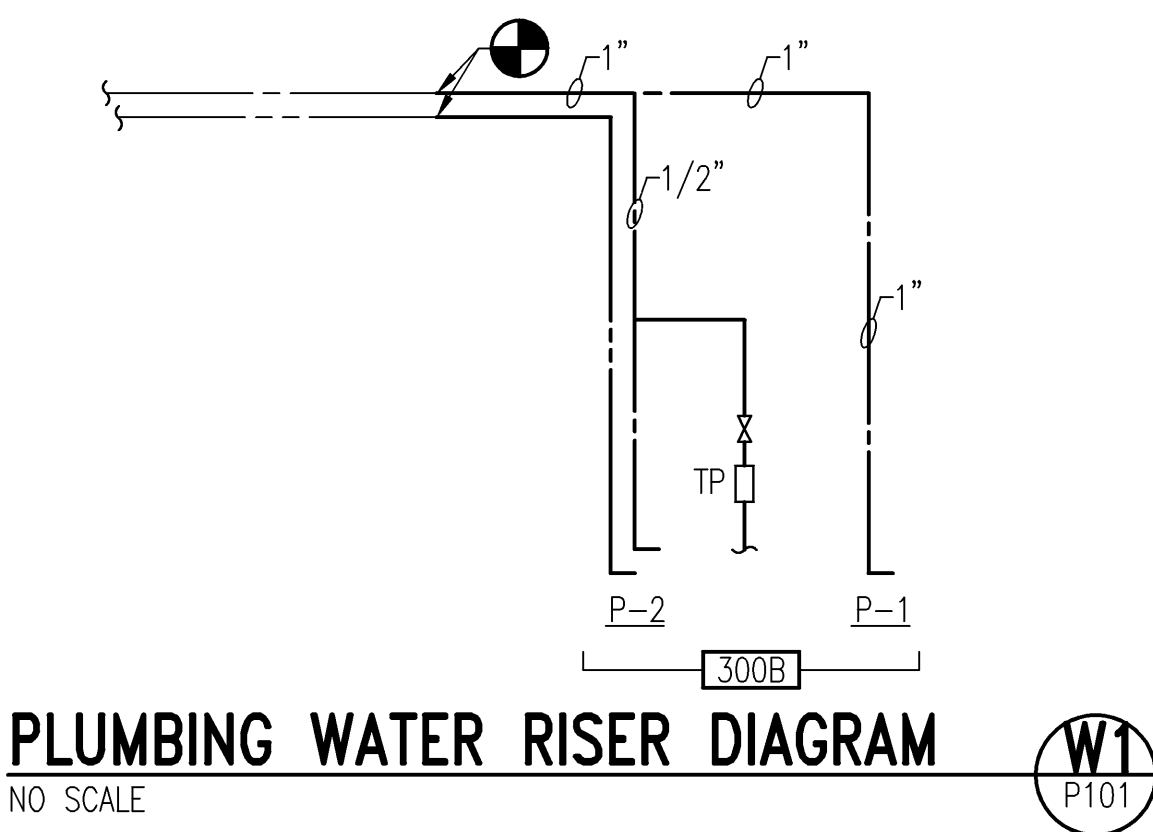

PLUMBING WATER RISER DIAGRAM W1
NO SCALE

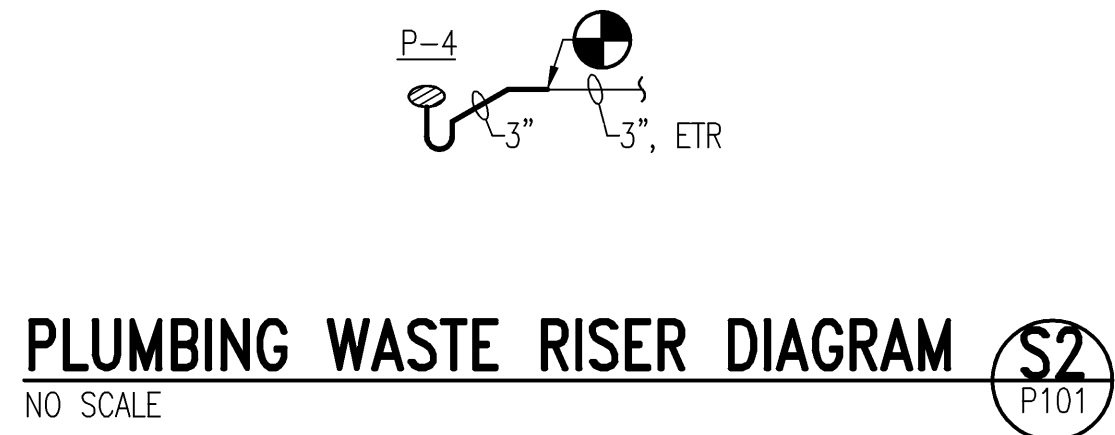

PLUMBING WASTE RISER DIAGRAM S2
NO SCALE

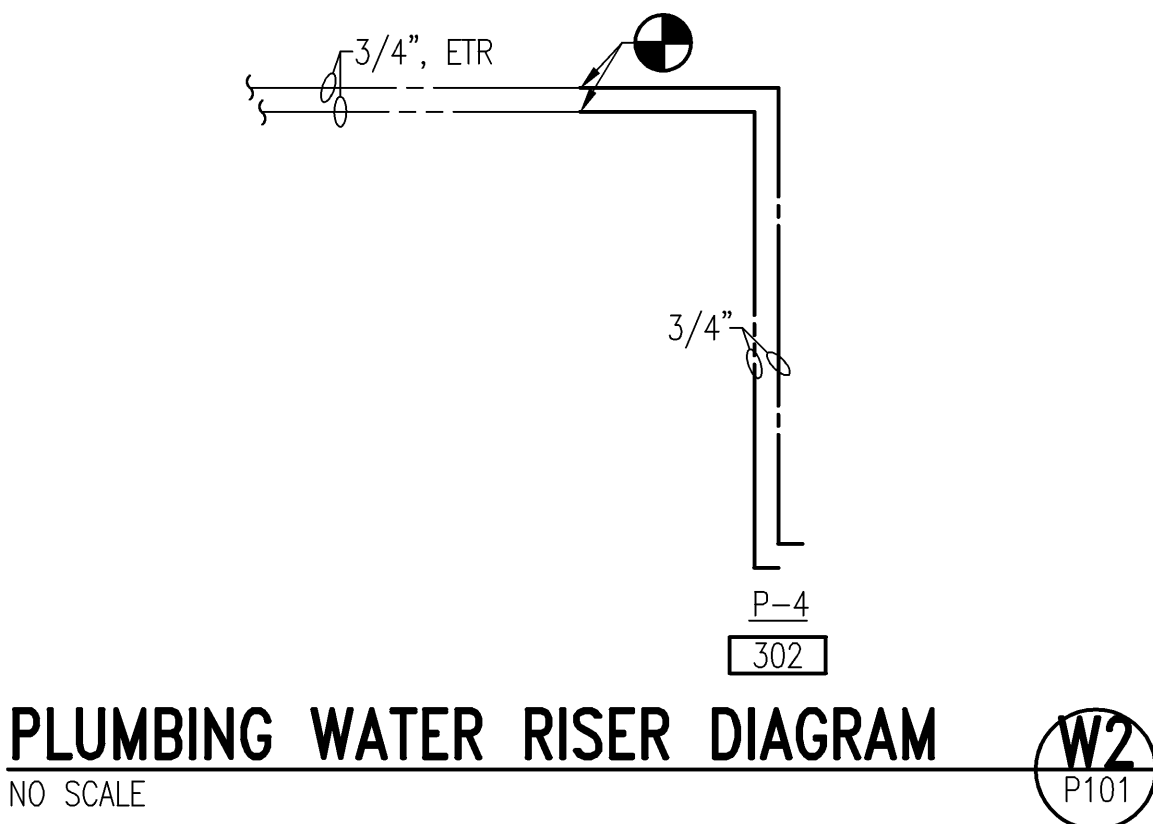

PLUMBING WATER RISER DIAGRAM W2
NO SCALE

Revisions:	CONSULTANTS: PACE COLLABORATIVE MECHANICAL ELECTRICAL ENGINEERS VIRGINIA BEACH, VA - 757-489-7223		ARCHITECT: INNOVATE Architecture • Interiors 441 WASHINGTON STREET PORTSMOUTH, VA 23704 (P) 757.393.9900 (F) 757.393.9907	Drawing Title PLUMBING NEW WORK THIRD FLOOR PLAN AND RISER DIAGRAMS Approved Project Director	Project Title VETERAN'S ADMINISTRATION HOSPITAL - HIGH TECH CONFERENCE ROOM RENOVATION Location FAYETTEVILLE, NORTH CAROLINA Date 05 - 14 - 12 Checked WGO Drawn MAJ	Project Number 565-11-101 Building Number 3 Drawing Number PL101 Dwg. 20 of 36	Office of Construction and Facilities Management Department of Veterans Affairs
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